

PARTIAL SIXTH FLOOR DEMOLITION PLAN - PHASE 6A

07/15/2016

05/10/2016

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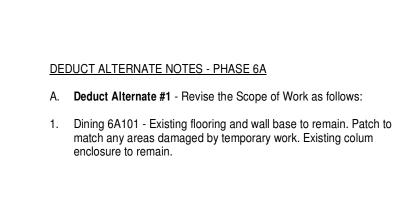
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Scale 1/8" = 1'-0"

91 8 16

Addendum

VA FORM 08-6231, OCT 1978




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#### **GENERAL DEMOLITION NOTES**

- A. Refer to Specifications Section 024100 "Demolition" for additional requirements and information. B. Project scope is indicated for general intent only. Additional demolition will be required inside and outside this line.
- Architectural demolition drawings are for schematic purposes. Coordinate all new penetrations and/or openings with other associated trades.
- D. The Owner shall remove, prior to construction, all items that the Owner desires to salvage. All remaining items indicated to be demolished shall be removed by the Contractor and legally disposed of in accordance with the project specifications.
- E. Contractor shall coordinate all demolition with the entire set of contract documents for full scope of demolition work required for F. Existing conditions shown on the drawings are not guaranteed to be complete. The Contractor shall verify all existing
- conditions, dimensions, and materials required for the contracted work. Report all discrepancies to COR prior to fabrication, erection, and/or installation.
- G. Contractor shall provide dust removing walk off mat (tacky mat) at construction entry points. Contractor shall enter construction areas at contractor access door in temporary partitions. Where individual rooms without a temporary partition are in a construction area, contractor entry point shall be through existing door(s).
- H. Contractor shall provide HEPA filtered negative air machine(s) to maintain negative pressure to scope of work area ensuring no dust will be transferred to occupied areas. Provide visual pressure monitoring device at dust proof barricade to confirm
- pressure. Dust monitoring shall be by Owner. See Infection Control Risk Assessment in specification section 01 35 26 I. All demolition work being done outside temporary partitions is to be appropriately sealed off to prevent the transmission of dust and debris. Work shall be done to minimize disruption to visitors, patients and staff. Coordinate location of barriers with the
- J. The hospital's smoke and fire suppression system shall remain in operation within the project scope area during the entire
- K. Field verify locations of all existing walls. Report any discrepancies to COR.
- L. Some items may be indicated in the demolition drawing and demolition notes which are not necessarily demolition work, but are included to describe the overall scope of the project and aid in the demolition coordination. The Contractor is responsible for all work required to complete the work of the overall project.
- M. Flooring demolition includes the removal of existing floor finishes, including VCT, sheet vinyl, ceramic tile, quarry tile, carpet and other finishes, grouts, mastics, and setting beds complete to existing concrete floor slab or other substrate ready for new floor finishes. Concealed multiple floor finishes may be present in several locations. Floor preparation shall be by the
- N. Remove partitions indicated to the underside of the structure above. O. Demolition of ceilings includes grid, tile, supports, soffits and related items as well as any ceiling mounted electrical and
- mechanical fixtures and supports contained within. Some areas in the project contain multiple ceilings. Contractor shall remove ceilings in the project area, U.N.O.
- P. Plug abandoned floor openings with new concrete. Plug shall match existing slab depth and shall be structurally sound to carry floor load of 100 LBS/SF U.N.O. Also see drawing 1-S1. Q. All fire rated assemblies (columns, shafts, walls, etc.) shall be maintained or be relocated/patched. Match existing fire rating
- R. Where new doors are indicated, cut openings in existing wall. Prepare openings for new door. Patch adjacent walls to match
- S. After removal of existing partitions, Contractor shall provide cementitious infill and floor leveler to prepare floor surface for new
- T. General Contractor to remove existing signage during each phase, patch and repair and damaged walls and prep walls for new
- finishes and new signage. See specifications 10 14 00 for sign schedule. U. See mechanical drawings for plumbing, HVAC and fire protection demolition. See electrical drawings for all power and lighting
- V. Debris removal shall not interfere with Owner's operations and shall occur during off hours as deteremined by COR. W. All noise generating operations, including cutting of ceilings, walls and floor, coring, drilling, etc. shall be scheduled between
- the hours of 8am and 5 pm. X. See asbestos abatement drawings for asbestos related work.
- Y. Contractor to protect all existing walls, ceilings and floor finishes scheduled to remain. Any surface(s) damaged by contractor shall be replaced by contractor at no additional cost to the Owner.
- Z. All areas outside of temporary partitions requiring new work are to be performed so as to minimize disruption to patients and

### TEMPORARY PARTITION NOTES

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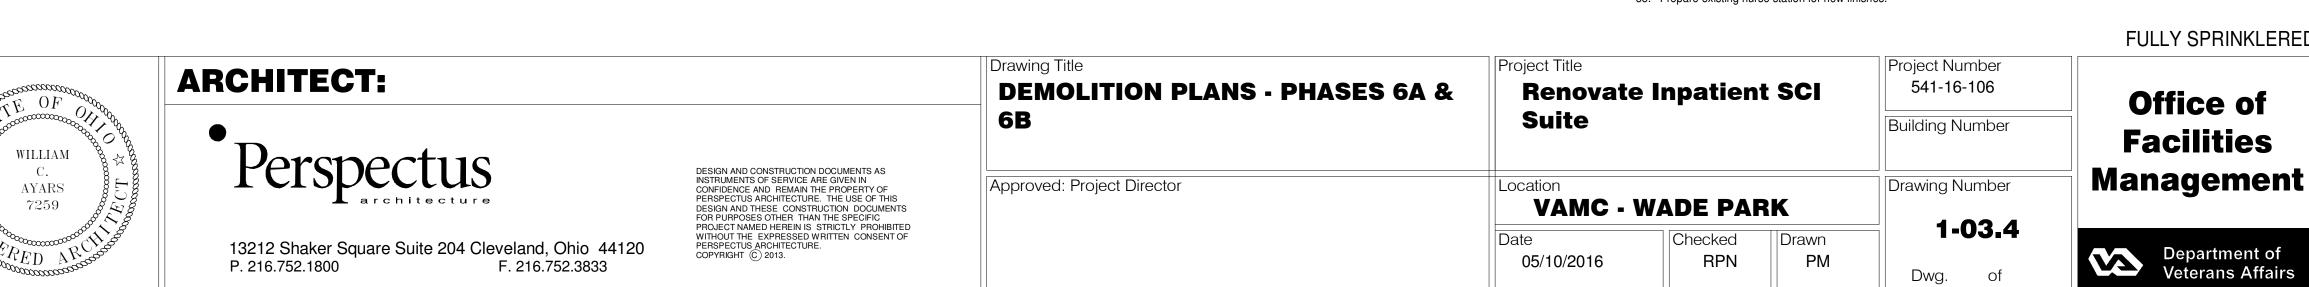
- A. Contractor shall at all times provide and/or maintain separation between Owner-occupied areas and areas under construction or partially constructed.
- B. Contractor shall construct and maintain at all times temporary partitions in accordance with Detail 2 on drawing 1-01.1 Temporary partitions shall be located to separate all Owner occupied areas from construction areas. Temporary partitions
- shall not interfere with Owner's operation of facilities. C. Temporary construction partitions and contractor access doors are to be constructed in their entirety prior to the start of
- D. Coordinate exact locations of temporary partitions with existing items in corridor ceilings and walls. Exit access corridors must remain adequately lit and ventilated throughout the construction process.
- E. Additional or modifications to the temporary partitions shown may be required due to sequencing of the work. Contractor shall determine location and quantity of all temporary partitions in accordance with ICRA and VA requirements prior to submittal of
- F. Remove temporary partitions completely after completion of work and when approved by COR. Patch all surfaces damaged by the installation or removal of partitions. G. Modification to the fire protection Life Safety system, or other system or device, may need to occur, if temporary partitions cover or conceal existing devices. Contractor shall temporarily relocate the affected devices to maintain their effectiveness.


## 6th FLOOR DEMOLITION CODED NOTES

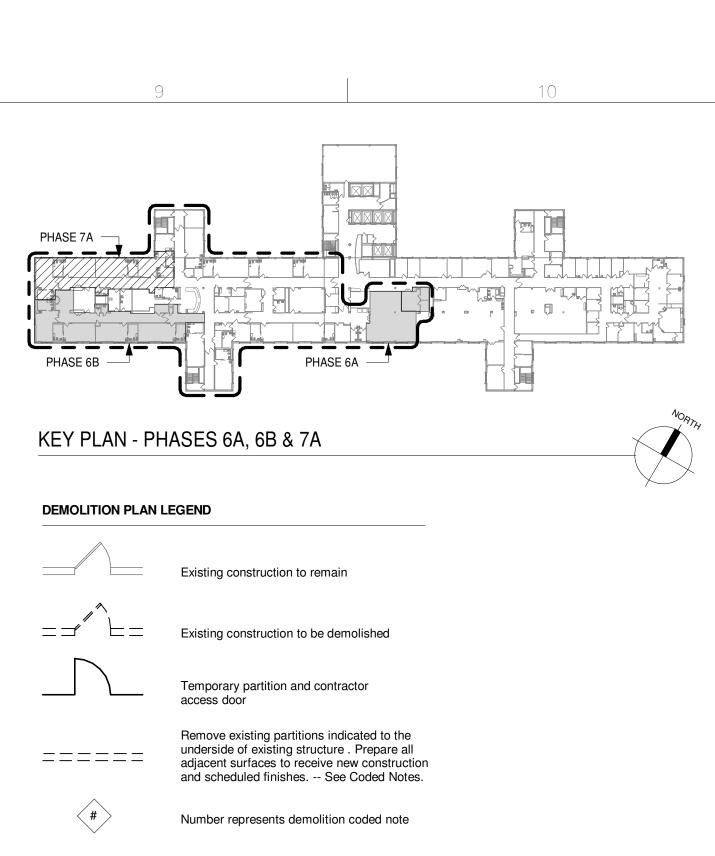- Note: Not all coded notes apply to this drawing.
- Remove existing wall hung sink. See plumbing drawings. Remove glass windows and frame, patch area for new construction and finishes.
- Remove existing flooring and wall base. Prepare existing surfaces to receive new scheduled finishes. Remove existing flooring, wall tile and wall base. Prepare existing surfaces to receive new scheduled finishes.
- Remove existing millwork cabinetry. Remove existing door, frame and associated hardware. Prepare and fill adjacent surfaces to receive new scheduled finishes. Remove existing bumper rail, corner guards and wall protection panels.
- Remove complete Wondoor system, including track and support framing. Remove wall from floor to underside of structure, patch and prepare adjacent surfaces to receive new scheduled finishes.
- 10. Remove portion of wall as required for new door and frame. 11. Remove existing gypsum board soffit, prepare area for new finishes and materials. Refer to Reflected Ceiling Plan.
- 12. Remove automatic door closers.
- Remove existing counter and sink. 14. Remove existing column covers complete. 15. Remove wall from floor to 8'-0" (Bulkhead)
- 16. Remove existing pair of doors and store for reinstallation at end of Phase 2. 17. Remove existing ceiling. 18., Remove existing window treatements/shades store and reinstall after installation of new finishes.
- 19. Temporarily seal door opening to prevent the migration of dust to occupied areas. Remove seal at conclusion of work this phase. 20. Maintain access this area during construction. Any closures must be coordinated with COR and must be short in duration. 21. Maintain emergency egress at all times through this area. See also Life Safety Plan.
- 22. Remove existing abandoned phone compartment millwork. 23. Remove existing fold down grab bar.
- 24. Maintain Owner access to Electrical panels at all times.
- 25. Remove existing semi recessed combined paper towel/waste dispenser and prepare wall for new finishes. 26. Provide temporary partition for temporary nourishment station prior to start of phase 5 work - see also electrical drawings.
- 27. Location of temporary partition for base bid and Deduct Alternate #1 and #2. 28. Location of temporary partition for Deduct Alternate #3. 29. Remove temporary ice machine installed in Phase 2.
- 30. Remove existing shelf and reinstall after installation of new finishes. 31. Remove existing sinks and other wall mounted devices to facilitate the installation of new wall protections panels. Reinstall devices after new wall protection panels are installed.
- 32. Contractor shall inspect remove and replace deteriorated drywall and framing prior to installation of new finishes. 33. Remove existing patient headwall in its entirety, including millwork, stainless steel guard rails, etc. Patch GYP BD and acoustical
- insulation, and prepare partition for new finishes. Refer also to Mechanical and Electrical drawings. 34. Remove existing door and hardware.
- 35. Prepare existing nurse station for new finishes.

**FULLY SPRINKLERED** Project Number 541-16-106 Office of Building Number

> Department of Veterans Affairs



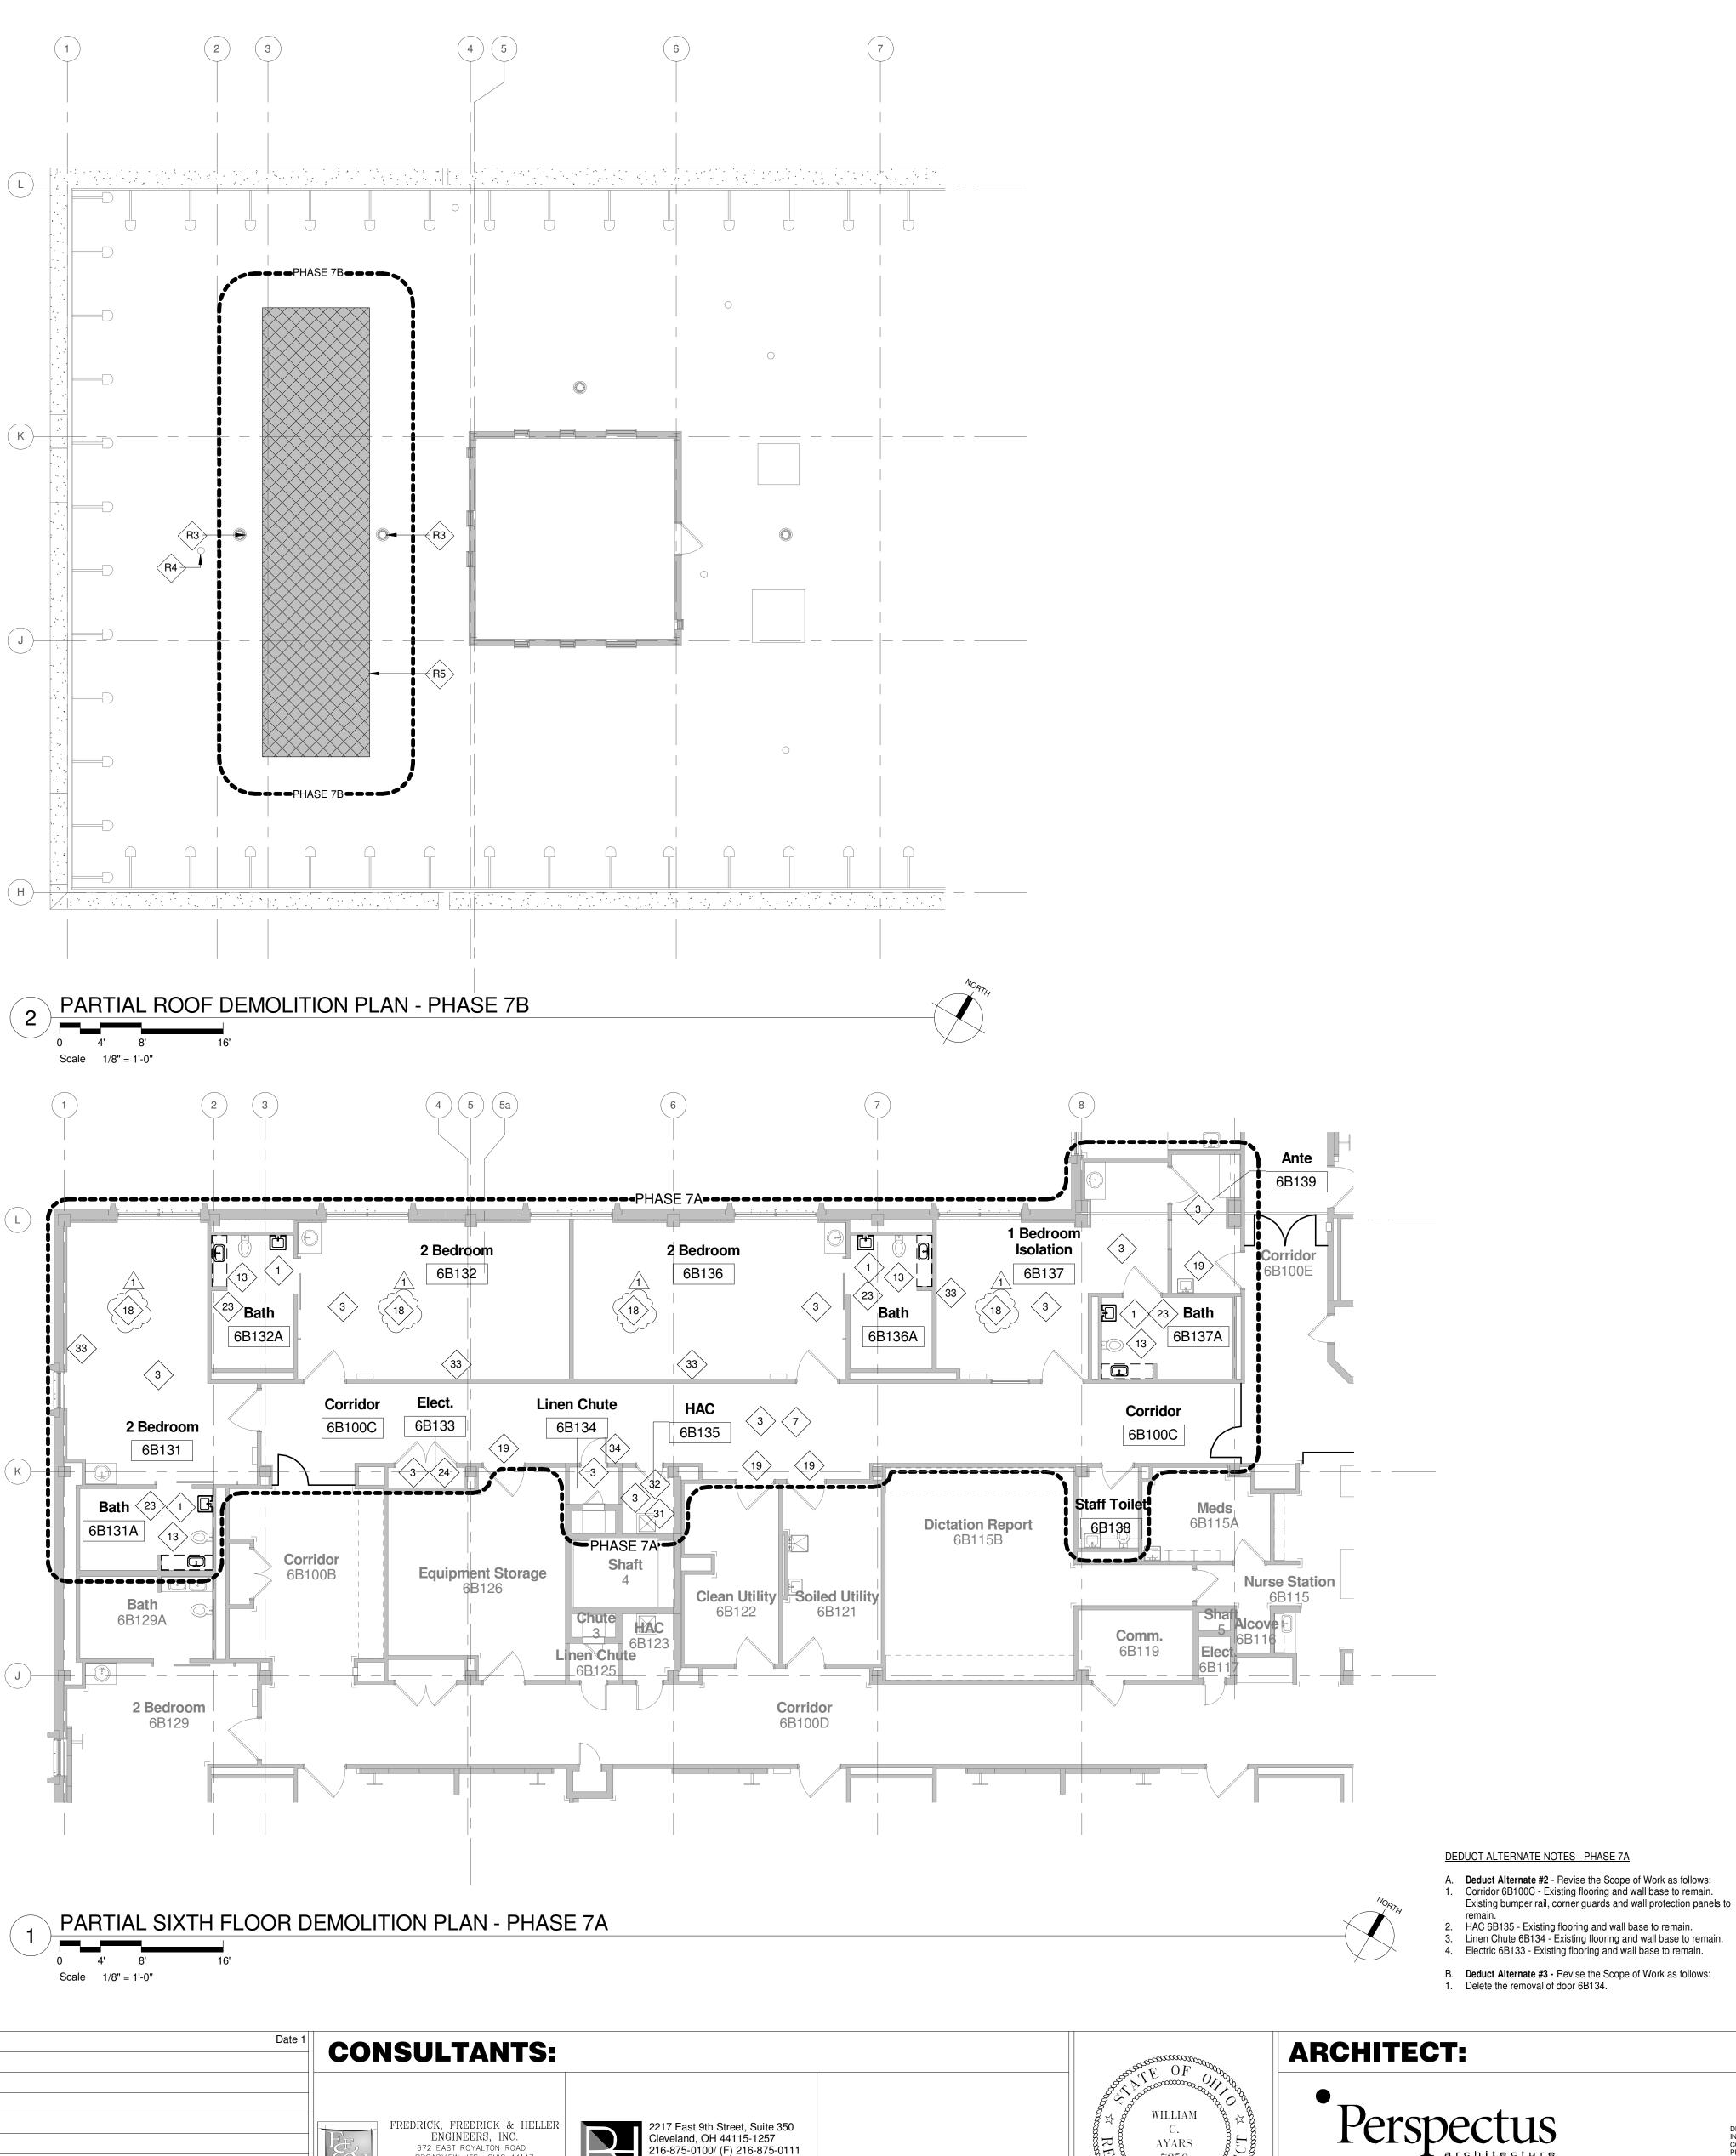

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7259

P. 216.752.1800

Revision 1

Addendum

VA FORM 08-6231, OCT 1978

**ROOF PLAN CODED NOTES** 

Note: Not all coded notes apply to this drawing.

- R1. Remove roof system completely in selected areas to facilitate the installation of new mechanical platform framing. Coordinate with Structural Drawing 1-S1.0.
- R2. Existing mechanical equipment shall remain in place.
- R3. Existing roof drain to remain in place. R4. Existing vent to remain in place.
- R5. Existing AHU-29 to be removed in Phase 7B. R6. Remove existing roof system and remove concrete slab for new mechanical penetration, Coordinate size and location with Structural and Mechanical drawings
- R7. Provide flashing and patch existing roof at new mechanical penetrations. See mechanical drawings for additional information R8. New duct work on equipment support roof curb. See Mechanical drawings for location size and quantity. Coordinate location of curbs with existing ballasted guardrail system @ roof edge. Provide weathertight installation @ each curb, See Detail 2
- R9. Relocate existing condensing unit see also Mechanical

building items affected by that work.

operate as before the removal.

#### **ROOF PLAN GENERAL NOTES**


- A. The existing Roof Assembly is warranted by the manufacturer and installing contractor. Preserve existing roofing system warranty using approved materials and methods. Notify warrantors before proceeding with roof patching. At completion of roof patching, notify warrantors to obtain documentation verifying that existing roofing system has been
- inspected and warranty remains in effect. Submit documentation to COR at project closeout B. Weather Limitations: Roofing assembly including flashings shall be water-tight and weather tight at the end of the day's work or when the weather is threatening. Protect roof deck, insulation and interior spaces from moisture at all times. Proceed with roof alterations only when existing and forecasted weather conditions permit roofing system to be opened up and re-installed according to manufacturer's written instruction and warranty requirements. Do not apply roofing membrane during inclement or windy weather with ambient temperatures below 40 °F and falling. During cold

2. All construction details and conditions shall comply with submitted and approved manufacturer's details.


D. In general, new materials and materials for repair conditions shall match similar items in quality, detail, profile, and finish as those already built into the Work unless otherwise indicated.

weather conditions, the temperature/humidity ratio must be at least 5°F above the dew point of ambient air and rising.

- E. Contractor to inspect existing roof at Work areas and to photographically document any damage prior to start of Work. Submit photographic documentation to Architect and COR. F. Contractor to provide temporary protection to protect the existing roof surface. Temporary protection shall be provided
- along access routes and at Work areas. G. The size and location of all roof openings and penetrations to be verified with trade affected before proceeding with the H. The contractor shall verify configuration of existing items penetrating the roof and existing items resting on the roof. I. In any area in which plumbing or mechanical alterations are made, the contractor shall make proper repairs to other
- J. Clean substrate of all debris and contaminants. Deck shall be dry before installation of any subsequent components or materials. Remove all debris from the premise and dispose of properly. K. After removal of existing roof membrane the COR must inspect substrate; such as deck, blocking cant strips, etc. The
- COR will determine if these concealed items must be repaired and/or replaced. This applies to all concealed items, even those called out on the drawings for removal. L. All mechanical equipment that has been removed, relocated or replaced to accommodate the roofing work shall
- M. Refer to Structural, Mechanical and Electrical drawings for additional Work beyond the Phasing Line.

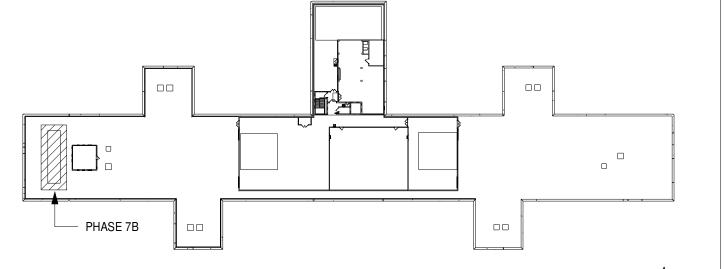

KEY PLAN - PHASE 7B

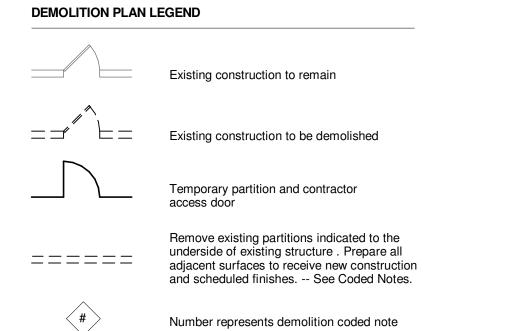

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541-16-106

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Office of **Facilities** Management

Veterans Affairs Department of

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Drawing Title

Approved: Project Director

**DEMOLITION PLANS - PHASES 7A &** 

05/10/2016

Project Title

Suite

**VAMC - WADE PARK** Drawn Checked RPN

**Renovate Inpatient SCI** 

**Drawing Number** 1-03.5 PM Dwg.

